



©2011 STARBUCKS COFFEE COMPANY

STARBUCKS COFFEE COMPANY
 2401 UTAH AVENUE SOUTH
 SEATTLE, WASHINGTON 98134
 (206) 318-1575

THESE DRAWINGS AND SPECIFICATIONS ARE CONFIDENTIAL AND SHALL REMAIN THE SOLE PROPERTY OF STARBUCKS CORPORATION, WHICH IS THE OWNER OF THE COPYRIGHT IN THIS WORK. THEY SHALL NOT BE REPRODUCED (IN WHOLE OR IN PART), SHARED WITH THIRD PARTIES OR USED IN ANY MANNER ON OTHER PROJECTS OR EXTENSIONS TO THIS PROJECT WITHOUT THE PRIOR WRITTEN CONSENT OF STARBUCKS CORPORATION. THESE DRAWINGS AND SPECIFICATIONS ARE INTENDED TO EXPRESS DESIGN INTENT FOR A PROTOTYPICAL STARBUCKS STORE (WHICH IS SUBJECT TO CHANGE AT ANYTIME) AND DO NOT REFLECT ACTUAL SITE CONDITIONS. NEITHER PARTY SHALL HAVE ANY OBLIGATION NOR LIABILITY TO THE OTHER (EXCEPT STATED ABOVE) UNTIL A WRITTEN AGREEMENT IS FULLY EXECUTED BY BOTH PARTIES.

ARCHITECT OF RECORD

NORR
 ARCHITECTS PLANNERS
 325 N. LaSalle St. Suite 700 Chicago, IL 60654
 t 312.424.2400 f 312.424.2424 www.norr.com

ENGINEER OF RECORD


 353 Marshall Avenue
 St. Louis, Missouri 63119
 Phone (314) 772-1782
 Fax (314) 373-3514
Engineering Consultants
 Mechanical - Electrical - Plumbing

Revision Schedule

Rev	Date	Description

PROJECT NAME:
Acton, Kelly's Corner
 PROJECT ADDRESS:
 411 Massachusetts Avenue
 Acton, MA 01720
 County: Middlesex

STORE #: 07835
 PROJECT #: 13423-027
 CONCEPT: NCS
 PALETTE: Regional Modern
 ISSUE DATE: 03.11.2013
 DESIGN MANAGER: E. Zakamarek
 LEED® AP: N/A
 PRODUCTION DESIGNER: NORR
 CHECKED BY: E. Fleming

SHEET TITLE:
Architectural Site Plan

SCALE: As indicated

SHEET NUMBER:
A-101

Architectural Site Plan Notes


- A. Refer to Exterior Elevations for Storefront Glazing and Door Placement.
- B. GC to provide all exterior site work.
- C. General Contractor to apply concrete sealer to all exterior concrete patio and walkway surfaces.

Sheet Notes

- 1. GC to seal and coat asphalt parking lot as required.

Parking Count

Existing to Remain: 25 Total Parking Stalls. 2 ADA Parking Stalls.

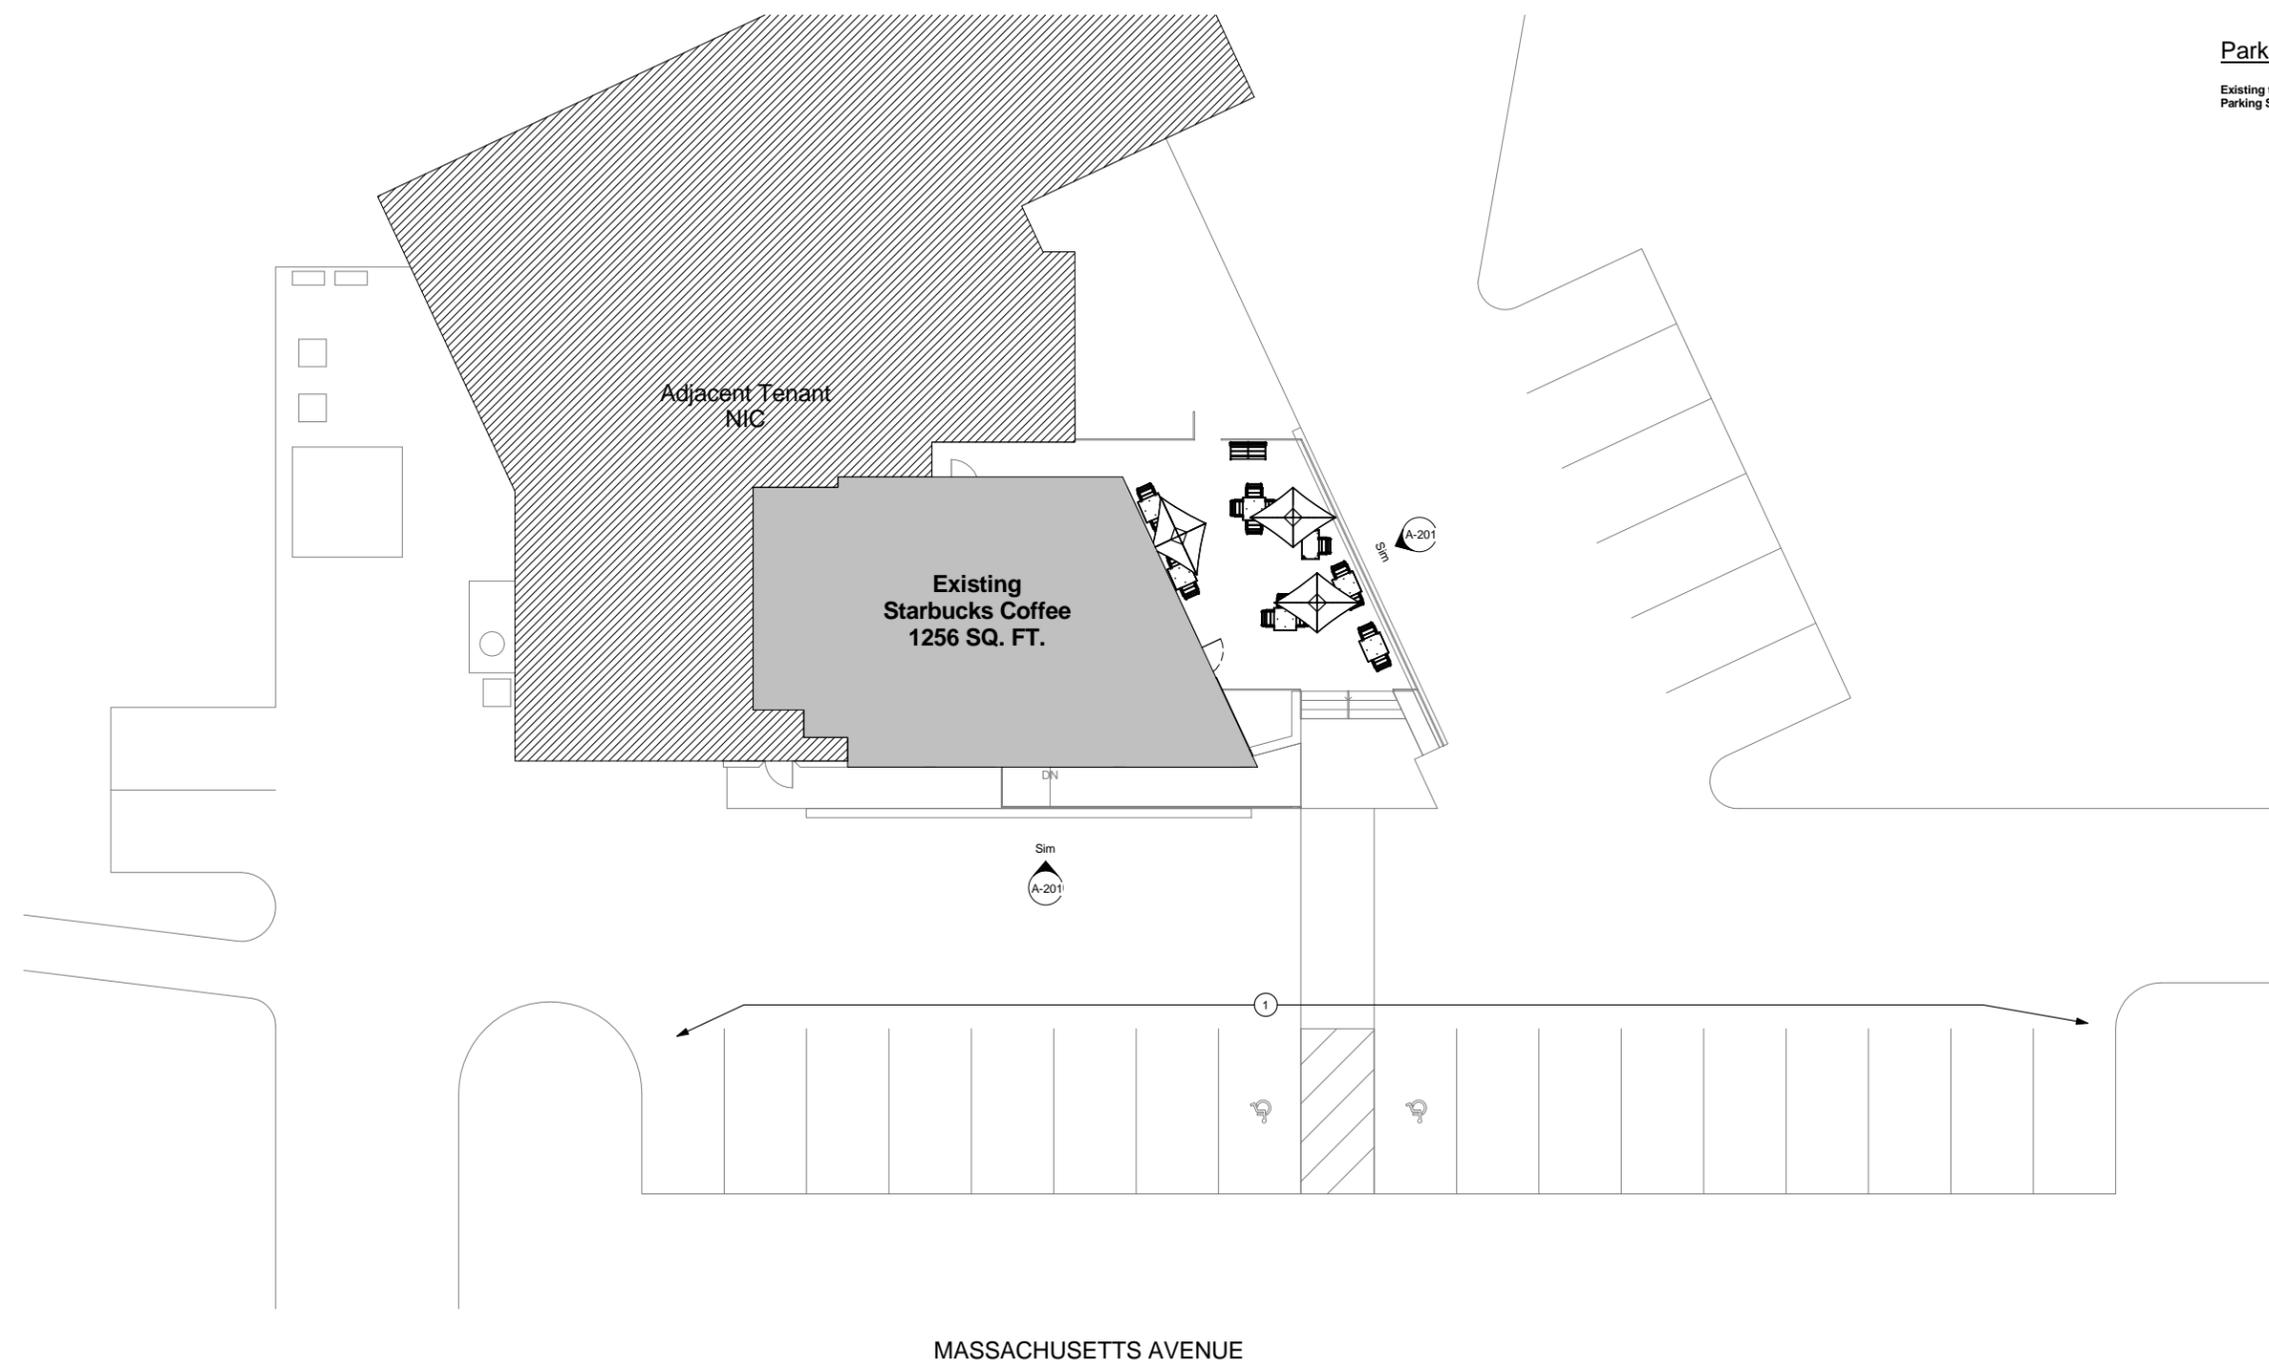

1 Architectural Site Plan

Scale: 1" = 10'-0"